

VILLAGE OF POMONA  
BOARD OF TRUSTEES MEETING  
JULY 25, 2022 8:00 PM

When: July 25, 2022 08:00 PM Eastern Time (US and Canada)

Topic: Village of Pomona: Board of Trustees meeting

Please click the link below to join the webinar:

[https://us02web.zoom.us/j/85476320901?pwd=TT6XZFqS6\\_hYvAHKtqECAsixsd-3wB.1](https://us02web.zoom.us/j/85476320901?pwd=TT6XZFqS6_hYvAHKtqECAsixsd-3wB.1)

Passcode: 10970

Or By Telephone:

1-929-205-6099

Webinar ID: 854 7632 0901

Passcode: 10970

**AGENDA**

SALUTE TO THE FLAG

OPEN PERIOD

APPROVAL OF AUDITED CLAIMS

CULTURAL CENTER REPORT

BUILDING AND ENGINEERING

PARKS AND RECREATION

NEW BUSINESS

A. HoW PRESENTATIONS

1. 7 HIDDEN VALLEY DRIVE

2. 60 HALLEY DRIVE

B. NORTH ROCKLAND SAFETY PATROL DISCUSSION

OLD BUSINESS

A. PERSONNEL POLICY

B. FISH IN – AUGUST 21, 2022

TRUSTEES PERIOD

OFFICE PERIOD

LEGAL

EXECUTIVE SESSION



**PLANTING NOTES**

1. ALL PLANTING SHALL BE PLANTED UNDER DIRECTION OF AN APPROPRIATE LICENSED LANDSCAPE ARCHITECT.
2. LOCATIONS OF PLANTING SHALL BE SHOWN BY THE ARCHITECT AND SHALL BE SUBJECT TO THE APPROVAL OF THE TOWN ENGINEER.
3. SPECIES OF PLANTS SHALL BE SPECIFIED BY THE ARCHITECT AND SHALL BE SUBJECT TO THE APPROVAL OF THE TOWN ENGINEER.
4. PLANTING SHALL BE PLANTED IN ACCORDANCE WITH THE TOWN ENGINEER'S SPECIFICATIONS AND SHALL BE SUBJECT TO THE APPROVAL OF THE TOWN ENGINEER.
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10. PLANTING SHALL BE PLANTED IN ACCORDANCE WITH THE TOWN ENGINEER'S SPECIFICATIONS AND SHALL BE SUBJECT TO THE APPROVAL OF THE TOWN ENGINEER.

**PLANTING**

- ⊗ TREE TO BE REMOVED
- TREE TO BE PROTECTED

ALL PLANTING SHALL BE PLANTED UNDER DIRECTION OF AN APPROPRIATE LICENSED LANDSCAPE ARCHITECT. LOCATIONS OF PLANTING SHALL BE SHOWN BY THE ARCHITECT AND SHALL BE SUBJECT TO THE APPROVAL OF THE TOWN ENGINEER. SPECIES OF PLANTS SHALL BE SPECIFIED BY THE ARCHITECT AND SHALL BE SUBJECT TO THE APPROVAL OF THE TOWN ENGINEER. PLANTING SHALL BE PLANTED IN ACCORDANCE WITH THE TOWN ENGINEER'S SPECIFICATIONS AND SHALL BE SUBJECT TO THE APPROVAL OF THE TOWN ENGINEER.

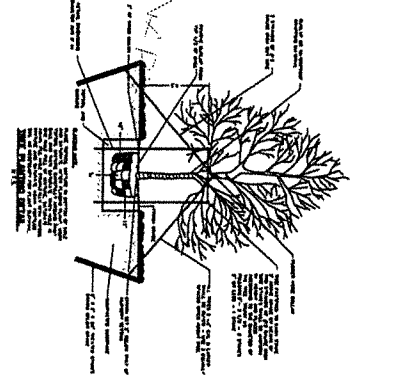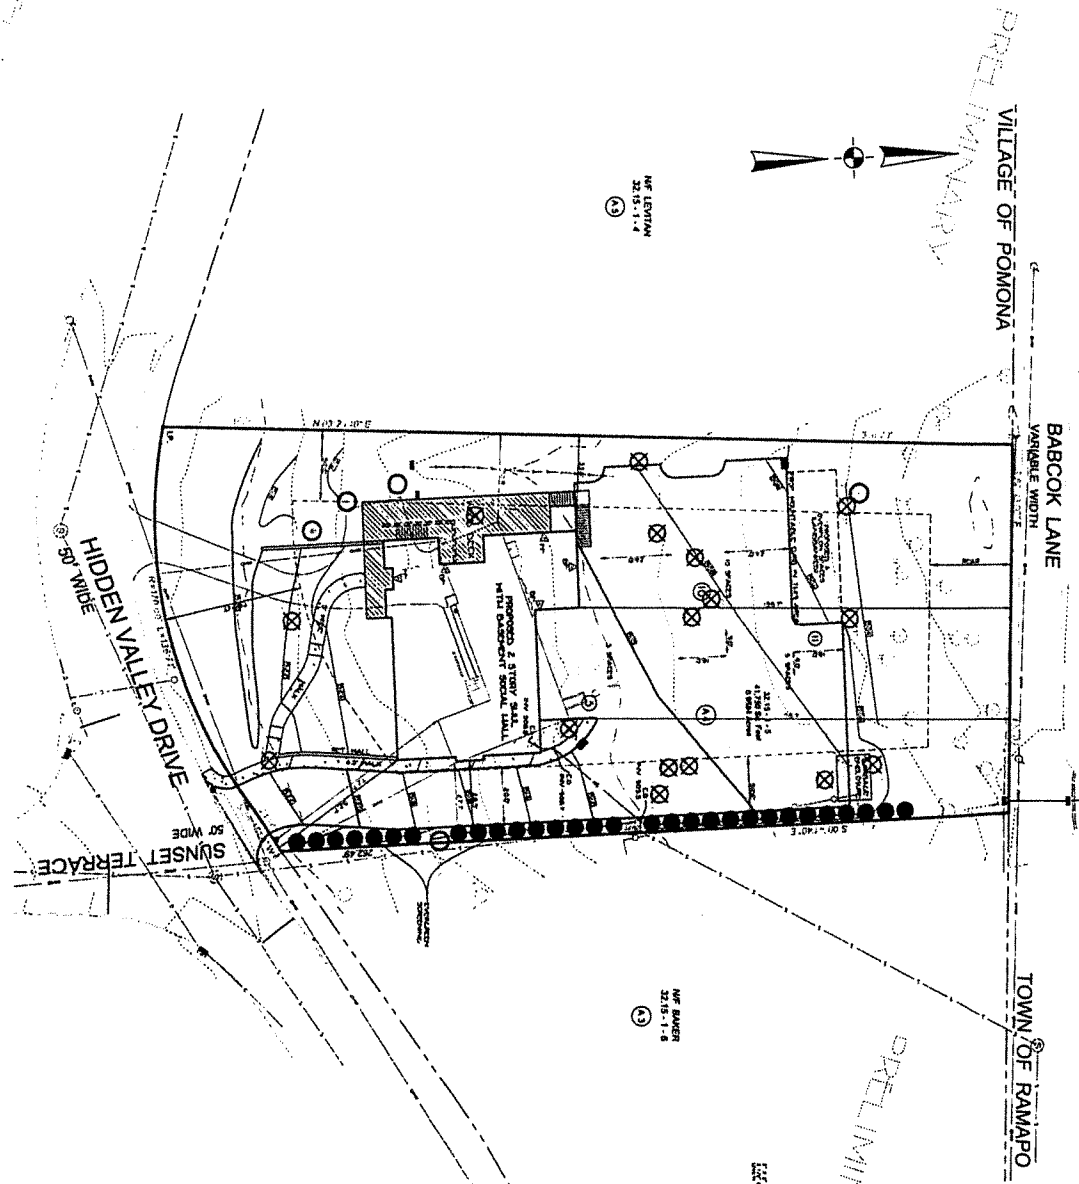

REVISIONS	
1	ISSUE FOR PERMIT
2	REVISED PER TOWN ENGINEER COMMENTS
3	REVISED PER TOWN ENGINEER COMMENTS
4	REVISED PER TOWN ENGINEER COMMENTS
5	REVISED PER TOWN ENGINEER COMMENTS

UNDESIGNED LUTTING PLAN  
7 HIDDEN VALLEY DRIVE  
VILLAGE OF POMONA  
LOCALITY MAP COUNTY OF NEW YORK

**SPARACO & YOUNGBLOOD, PLLC**  
CIVIL, STRUCTURAL, & LAND SURVEYORS  
12345 MAIN STREET  
SUITE 100  
PO BOX 12345  
NEW YORK, NY 10001  
PHONE: (212) 123-4567  
FAX: (212) 123-4568  
WWW.SPARACO.COM


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DATE: 1-1-23



**GENERAL NOTES**



1. CONTRACTOR SHALL VERIFY ALL UTILITIES DEPICTED ON ALL SHEETS.
2. ALL UTILITIES SHALL BE PROTECTED BY A MINIMUM OF 18" OF CONCRETE OR 24" OF ASPHALT.
3. ALL UTILITIES SHALL BE PROTECTED BY A MINIMUM OF 18" OF CONCRETE OR 24" OF ASPHALT.
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**STANDARD SYMBOLS AND NOTATION**

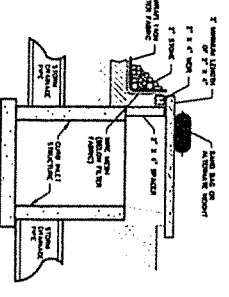


**STANDARD SYMBOLS AND NOTATION**


1. CURB INLET PROTECTION SHALL BE 18" HIGH AND 18" WIDE.
2. CURB INLET PROTECTION SHALL BE 18" HIGH AND 18" WIDE.
3. CURB INLET PROTECTION SHALL BE 18" HIGH AND 18" WIDE.
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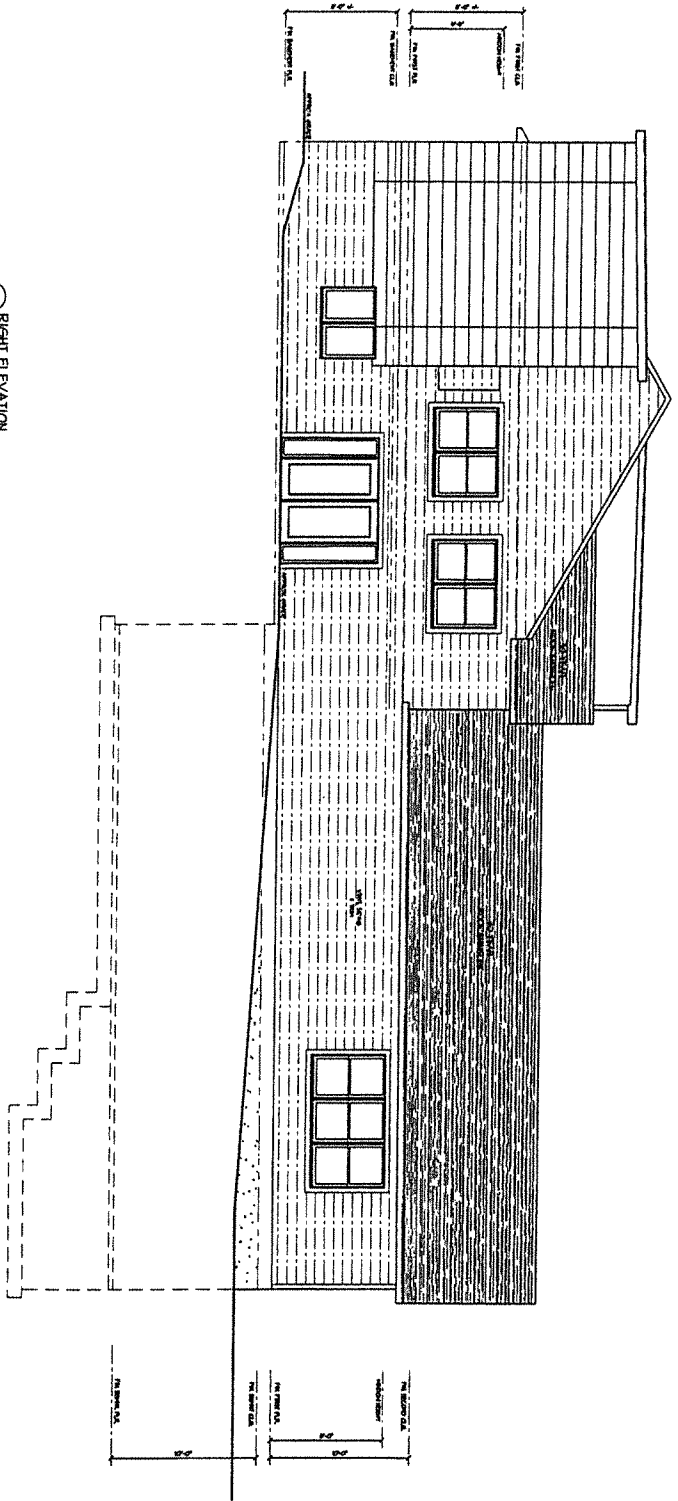
- NOTES**
1. CURB INLET PROTECTION SHALL BE 18" HIGH AND 18" WIDE.
  2. CURB INLET PROTECTION SHALL BE 18" HIGH AND 18" WIDE.
  3. CURB INLET PROTECTION SHALL BE 18" HIGH AND 18" WIDE.
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NO.	DATE	DESCRIPTION
1	3/1/17	ISSUED FOR PERMIT
2	3/15/17	REVISED PER COMMENTS
3	3/22/17	REVISED PER COMMENTS
4	3/29/17	REVISED PER COMMENTS
5	4/5/17	REVISED PER COMMENTS
6	4/12/17	REVISED PER COMMENTS
7	4/19/17	REVISED PER COMMENTS
8	4/26/17	REVISED PER COMMENTS
9	5/3/17	REVISED PER COMMENTS
10	5/10/17	REVISED PER COMMENTS

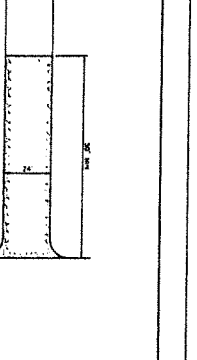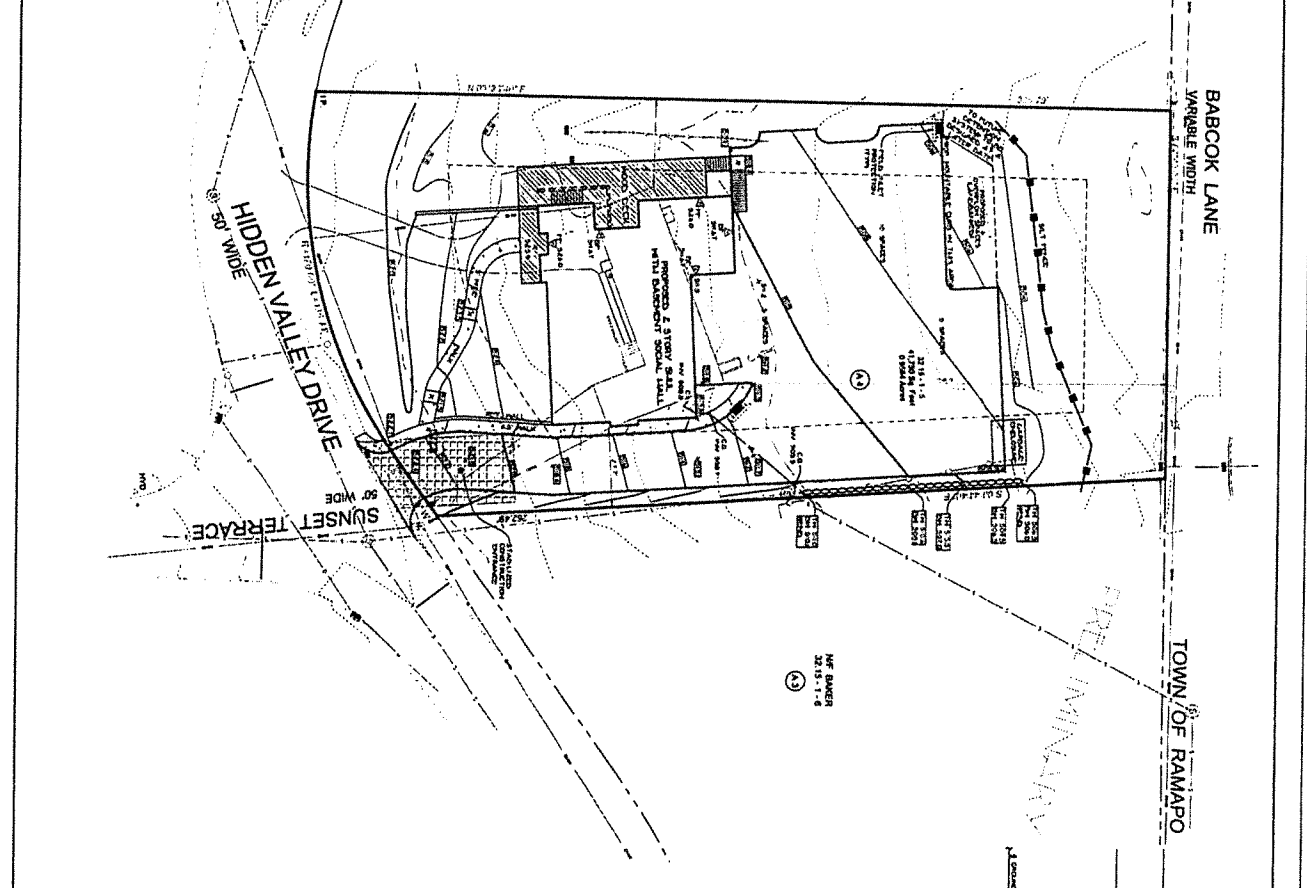

① FRONT ELEVATION  
SCALE: 1/8" = 1'-0"

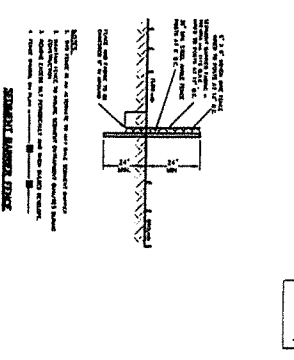

② RIGHT ELEVATION  
SCALE: 1/8" = 1'-0"
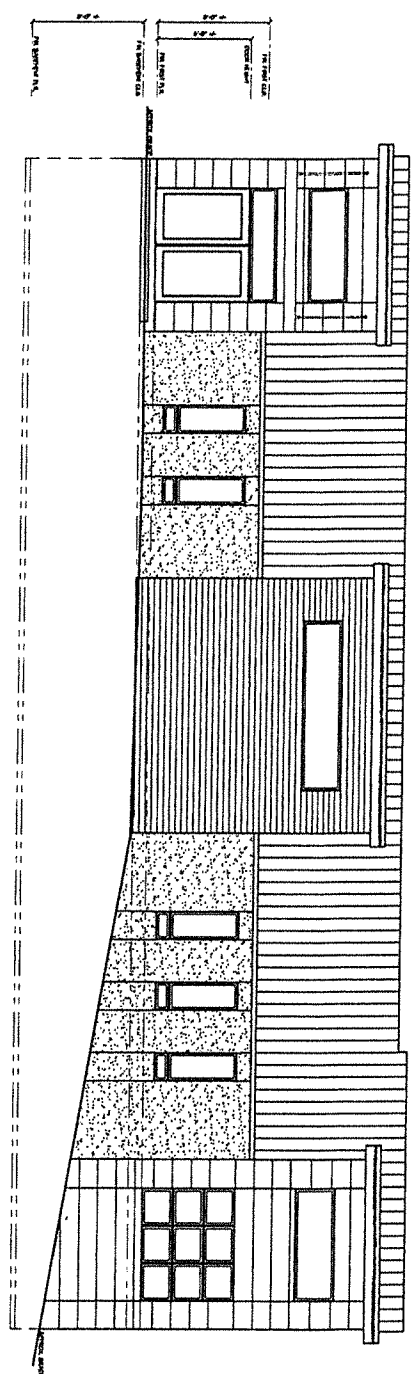
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PROJECT NO.  
**A-1 of 10**

CONTRACTOR'S NAME:  
**FRONT & RIGHT ELEVATIONS**

PROJECT NO.:  
**G-1228**

DATE: **1/24/22**

SCALE: **1/8" = 1'-0"**


PROJECT NAME:  
**60 HALLEY DRIVE**

LOCATION:  
**VILLAGE OF POMONA, ROCKLAND COUNTY, NY**



PROPOSED RENOVATIONS FOR:  
**60 HALLEY DRIVE**  
25.09 - 1 - 33  
60 HALLEY DRIVE, POMONA NY 10970  
VILLAGE OF POMONA, ROCKLAND COUNTY, NY

**WILLIAM BATEMAN ARCHITECT**  
144 Route 59, Suite 2  
Suffern, NY 10981  
Tel. 845.517.0094  
Fax. 845.517.0095

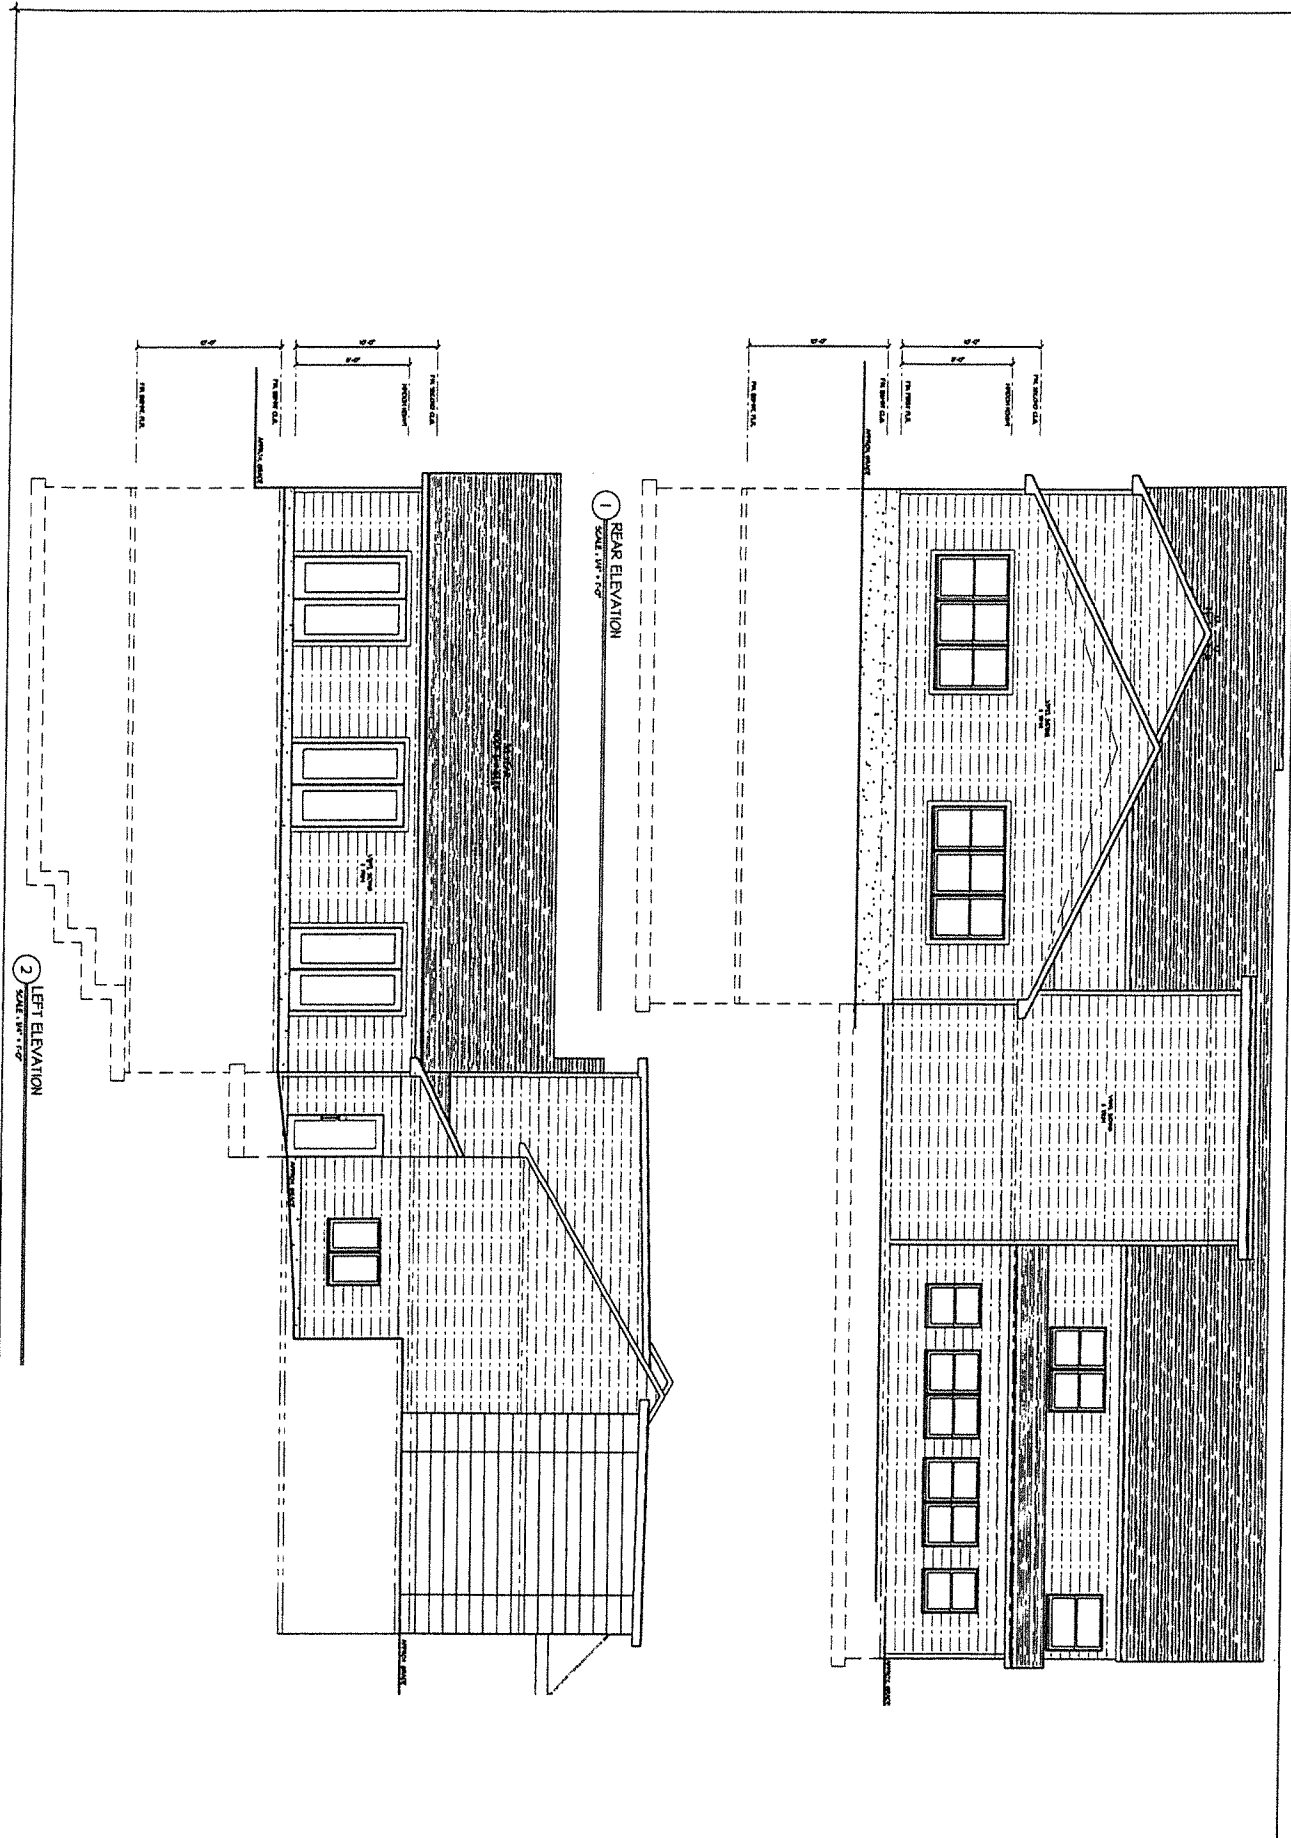

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	<b>WILLIAM BATEMAN ARCHITECT</b> 144 Route 39, Suite 2 Suffern, NY 10901 Tel. 845.517.0094 Fax. 845.517.0095
	<b>PROPOSED RENOVATIONS FOR:</b> <b>60 HALLEY DRIVE</b> 25.09 - 1 - 33 60 HALLEY DRIVE, POMONA NY 10970 VILLAGE OF POMONA, ROCKLAND COUNTY, NY
DATES: 01/22 PERMISSIBLON	PROJECT NO.: G-1208
DRAWN BY: Y.F.	CHECKED BY: J.F.
PROJECT FOR: DEAN & LEFT ELEVATIONS	
SHEET NO.: A-2 of 10	

**GENERAL NOTES**

1. ALL WORK SHALL BE IN ACCORDANCE WITH THE SPECIFICATIONS AND CODES OF THE STATE OF NEW YORK AND THE CITY OF POMONA, NEW YORK. THE CONTRACTOR SHALL BE RESPONSIBLE FOR OBTAINING ALL NECESSARY PERMITS AND APPROVALS FROM THE APPROPRIATE AGENCIES.

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**CLIMATE & GEOGRAPHIC DESIGN CRITERIA**

PARAMETER	UNIT	VALUE
WIND SPEED	MPH	35
TEMPERATURE	°F	65
RELATIVE HUMIDITY	%	65
PRECIPITATION	IN	48
ICE LOAD	PSF	20
SEISMIC	MS </td <td>0.1</td>	0.1

**INSULATION AND FENESTRATION REQUIREMENTS BY COMPONENT**

COMPONENT	U-VALUE	R-VALUE	GLAZING
ROOF	0.04	25	None
WALLS	0.09	11	None
FLOORS	0.05	20	None
WINDOWS	0.35	2.9	Low E, Argon
DOORS	0.18	5.6	None

**BUILDING INFORMATION**

Project Name: 60 Halley Drive Renovations  
 Address: 60 Halley Drive, Pomona, NY 10970  
 Owner: Village of Pomona  
 Architect: William Bateman Architect  
 Date: 12/15/2023

**FLOOR AREA**



AREA	AREA (SQ FT)
1ST FLOOR	10,500
2ND FLOOR	10,500
MECH. ROOM	1,000
STAIRS	1,000
TOTAL	23,000

**PERFORMANCE NOTES**

1. All insulation shall be installed in accordance with the manufacturer's instructions.

2. All fenestration shall be installed in accordance with the manufacturer's instructions.

3. All work shall be in accordance with the applicable codes and standards.

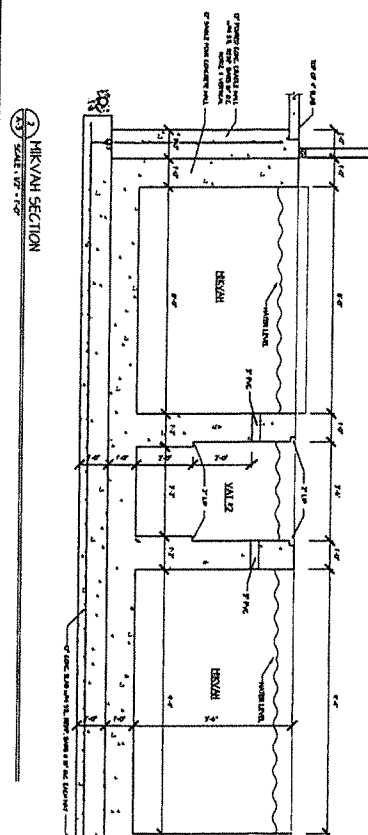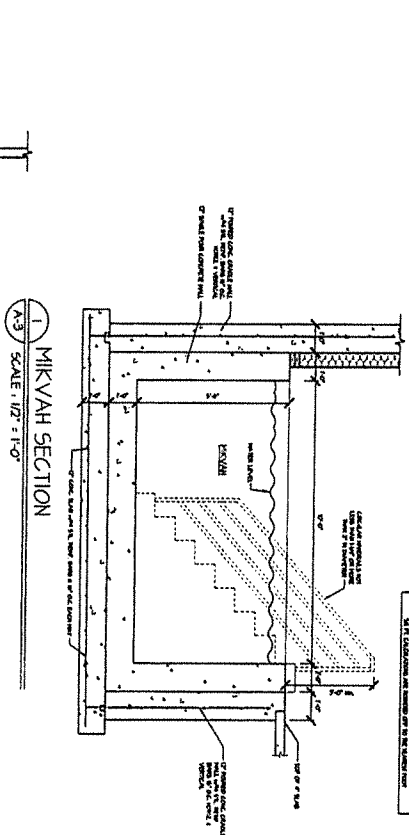

**WILLIAM BATEMAN ARCHITECT**

144 Route 99, Suite 2  
 Shiloh, NY 10901  
 Tel: 845.517.0094  
 Fax: 845.517.0095


**PROPOSED RENOVATIONS FOR:**  
**60 HALLEY DRIVE**  
 25.09 - 1 - 33  
 60 HALLEY DRIVE, POMONA NY 10970  
 VILLAGE OF POMONA, ROCKLAND COUNTY, NY

DATE: 01.12.2024  
 DRAWN BY: [Signature]  
 CHECKED BY: [Signature]


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SHEET NO: A-3 of 10


1 FOUNDATION PLAN  
SCALE: 1/8" = 1'-0"

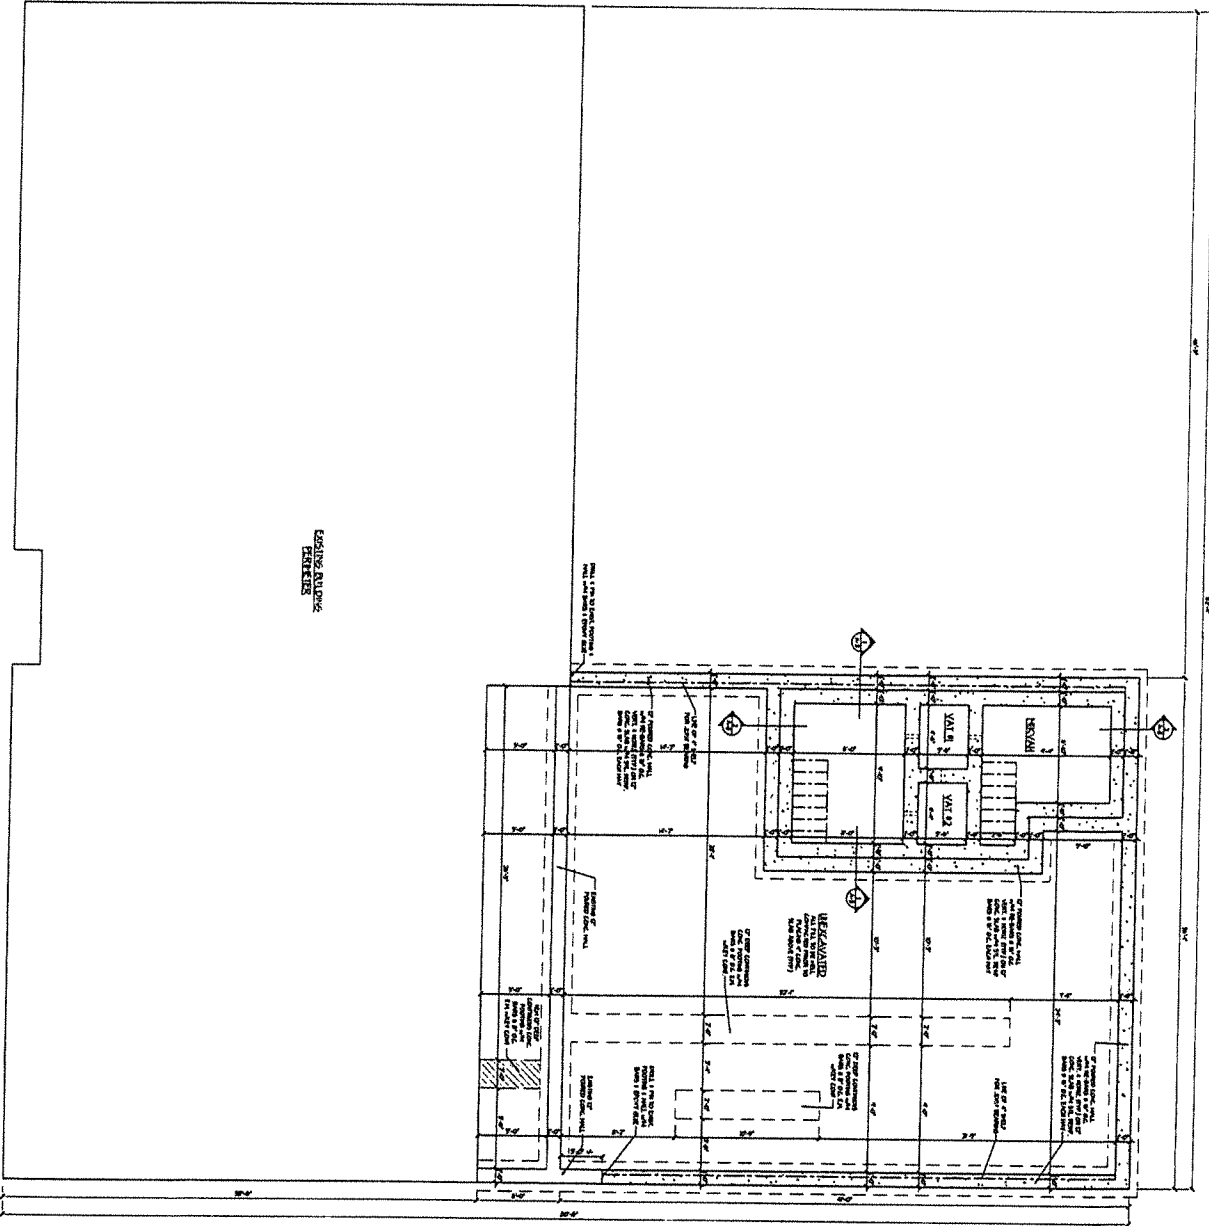

2 POST TO FOOTING & POST TO GIRDER DETAIL  
SCALE: 1/4" = 1'-0"

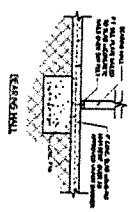

3 STEP FOOTING  
SCALE: 1/4" = 1'-0"

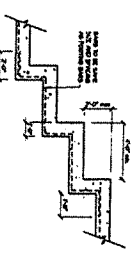

**SCALE LEGEND**

EXISTING BUILDING	SOLID LINE
PROPOSED BUILDING	DASH-dot LINE
PROPOSED COLUMN	CIRCLE WITH CROSS
PROPOSED FOOTING	SQUARE WITH CROSS
PROPOSED GIRDER	DOUBLE DASH-dot LINE

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PROJECT NO.	G-1220
DATE	Y.F.
SCALE	AS NOTED
CLIENT	CLIENT OF JOHN HENRY
FOUNDATION PLAN	
DETAILS	




PROPOSED RENOVATIONS FOR  
**60 HALLEY DRIVE**  
25.09 - 1 - 33  
60 HALLEY DRIVE, POMONA NY 10970  
VILLAGE OF POMONA, ROCKLAND COUNTY, NY

**WILLIAM BATEMAN ARCHITECT**  
144 Route 59, Suite 2  
Sullivan, NY 10991  
Tel: 845.517.0894  
Fax: 845.517.0895





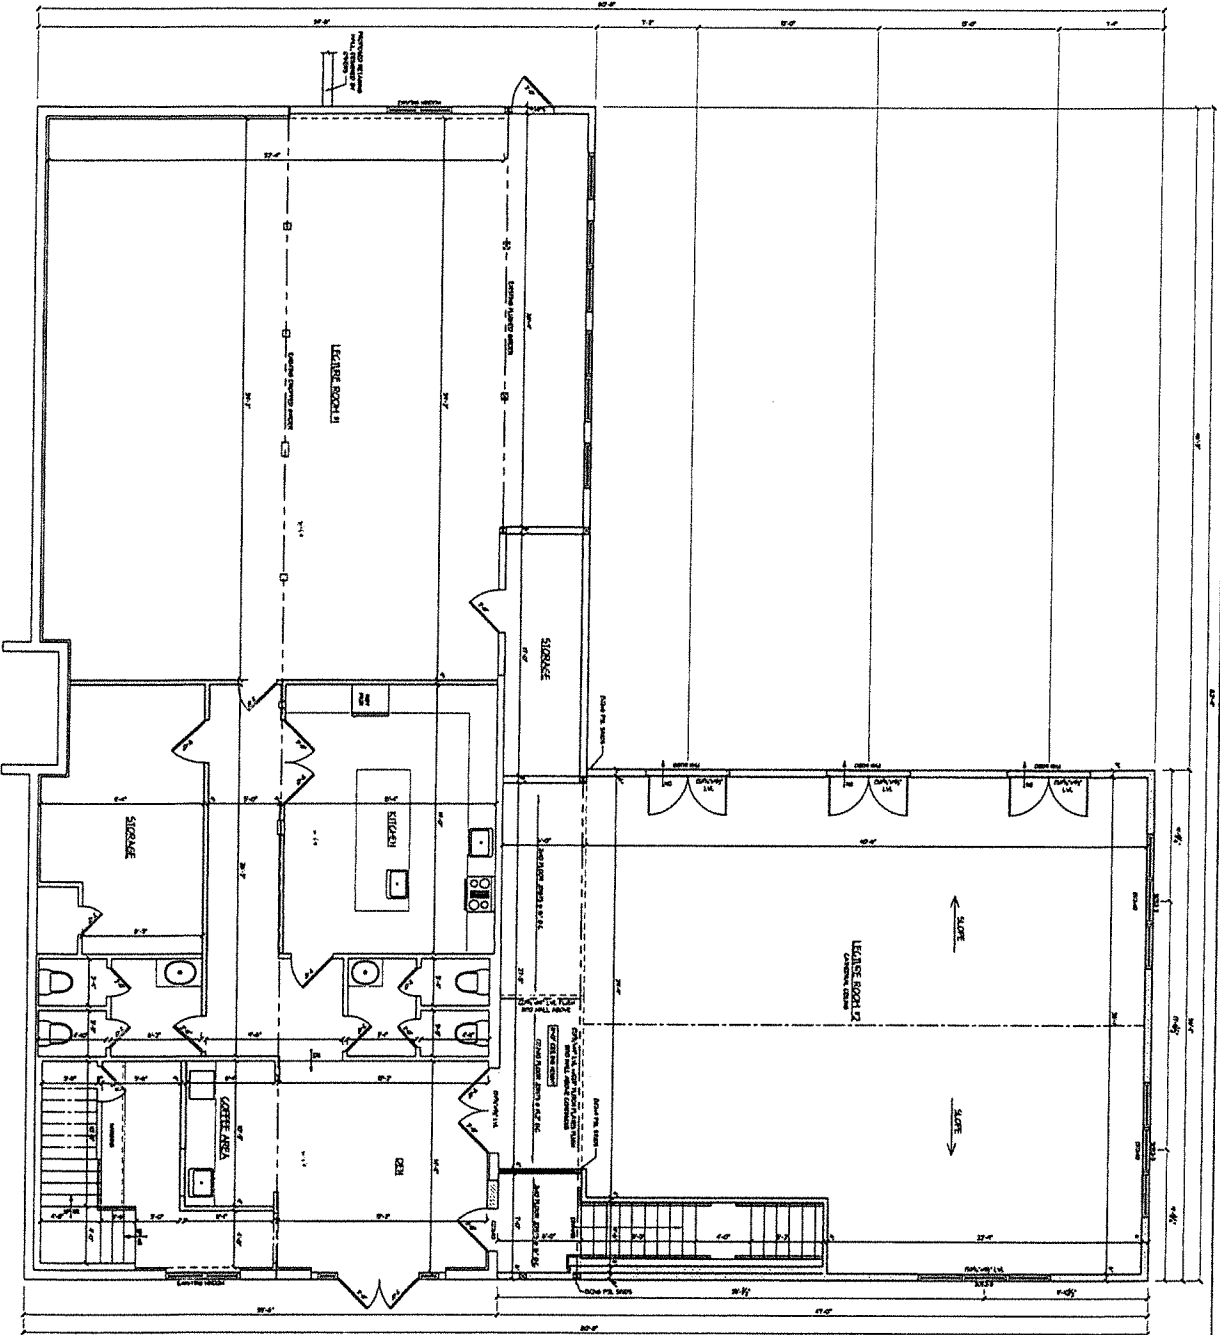

1 BASEMENT FLOOR PLAN  
SCALE: 1/8" = 1'-0"

**SMALL LEGEND**

---	Change of Level
---	Change of Floor
---	Change of Ceiling
---	Change of Wall
---	Change of Partition
---	Change of Door
---	Change of Window
---	Change of Stair
---	Change of Elevation

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PROJECT NO.  
**A-6 of 10**

PROJECT NO.  
G-1120

DATE  
1/1/20

SCALE  
1/8" = 1'-0"

CONTRACTOR  
M.A.N.

PROJECT NAME  
BASEMENT FLOOR

DATE  
01/12/2020

SCALE  
AS SHOWN

PROJECT NO.  
G-1120

DATE  
1/1/20

CONTRACTOR  
M.A.N.

PROJECT NAME  
BASEMENT FLOOR



PROPOSED RENOVATIONS FOR:  
**60 HALLEY DRIVE**  
25.09 - 1 - 33  
60 HALLEY DRIVE, POMONA NY 10970  
VILLAGE OF POMONA, ROCKLAND COUNTY, NY

**WILLIAM BATEMAN ARCHITECT**


144 Route 59, Suite 2  
Suffern, NY 10981  
Tel: 845.517.0094  
Fax: 845.517.0095



1 ROOF PLAN  
SCALE: 1/8" = 1'-0"

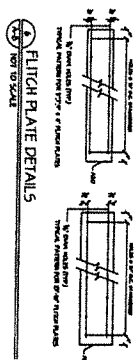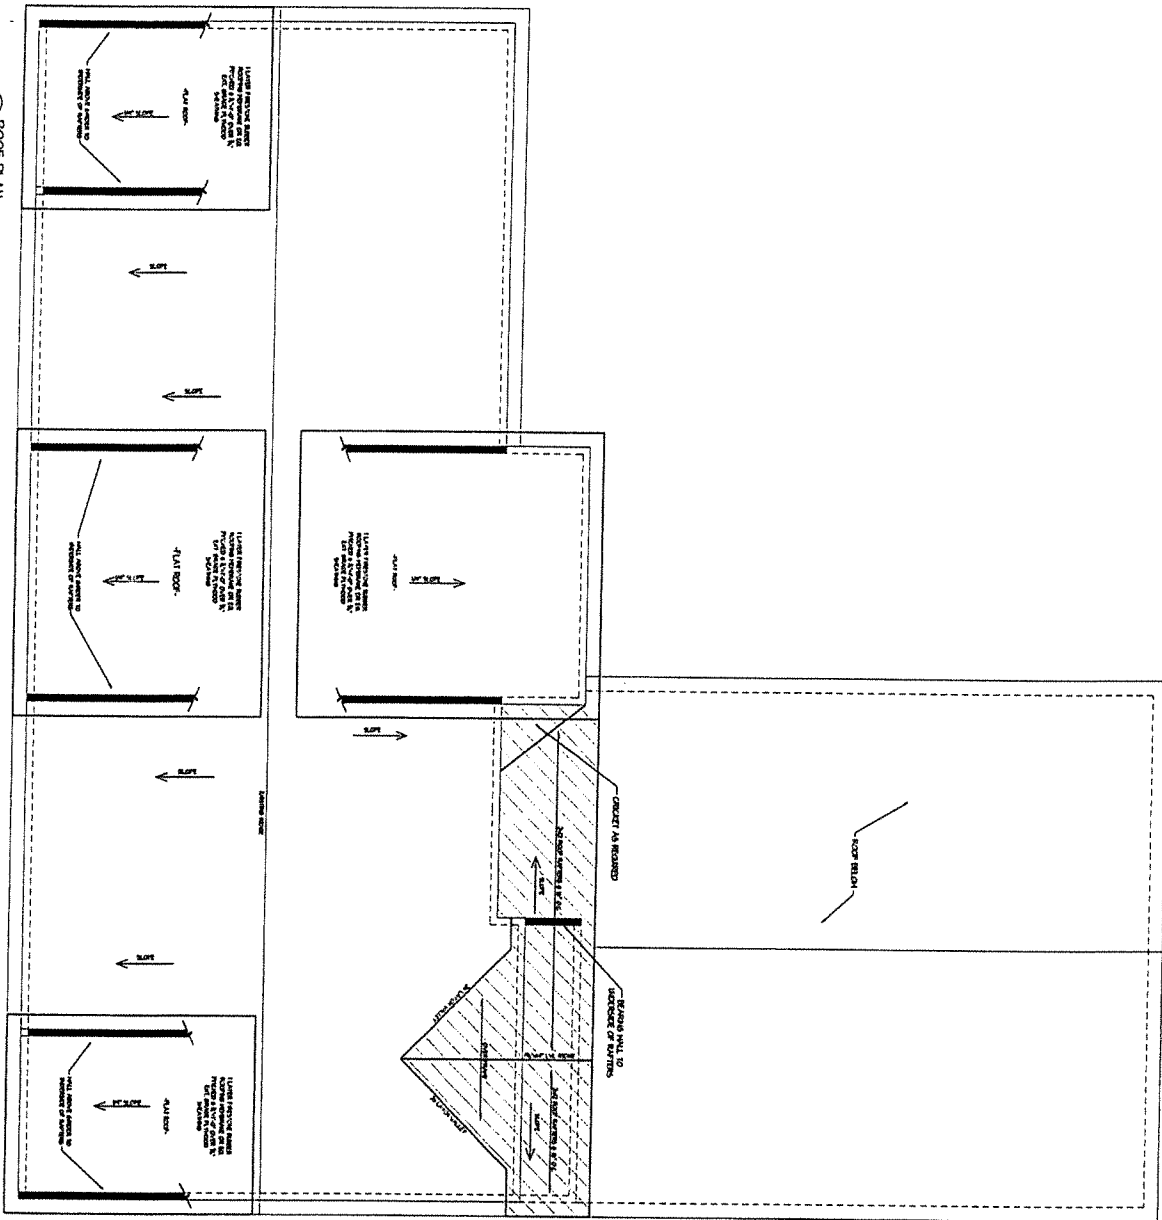


26 TOP PLATE FRAMING TO ACCOMPANY PIPING  
NOT TO SCALE

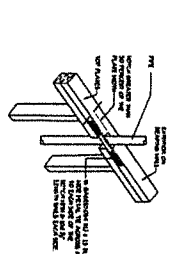


27 CUTTING, NOTCHING & DRILLING  
NOT TO SCALE



28 NOTCHING & BORING HOLE LIMITATIONS FOR EXTERIOR WALLS & BEARING WALLS  
NOT TO SCALE

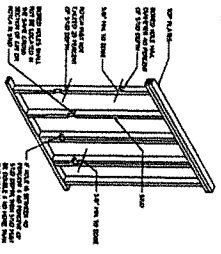

29 BEAM-COLUMN CONNECTION  
NOT TO SCALE

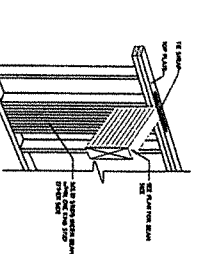

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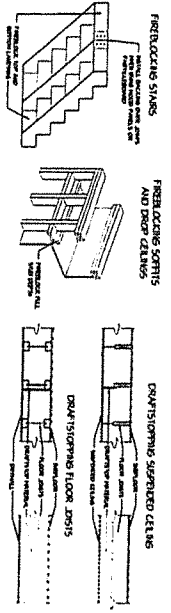
SHEET NO. A-8 of 10

PROJECT NO.	G-1230
DATE	Y.F.
DESIGNED BY	AS NOTED
CHECKED BY	WILLIAM BATEMAN
PROJECT NAME	ROOF PLAN DETAILS




PROPOSED RENOVATIONS FOR:  
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25.09 - 1 - 33  
60 HALLEY DRIVE, POMONA NY 10970  
VILLAGE OF POMONA, ROCKLAND COUNTY, NY


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Tel. 845.517.0094  
Fax. 845.517.0095




**FIREBLOCKING STAIRS**  
 1. ALL CONSTRUCTION SHALL BE IN ACCORDANCE WITH THE LATEST EDITIONS OF THE NATIONAL FIRE PROTECTION ASSOCIATION (NFPA) 101, LIFE SAFETY CODE, AND THE INTERNATIONAL BUILDING CODE (IBC).  
 2. ALL CONSTRUCTION SHALL BE IN ACCORDANCE WITH THE LATEST EDITIONS OF THE NATIONAL FIRE PROTECTION ASSOCIATION (NFPA) 101, LIFE SAFETY CODE, AND THE INTERNATIONAL BUILDING CODE (IBC).  
 3. ALL CONSTRUCTION SHALL BE IN ACCORDANCE WITH THE LATEST EDITIONS OF THE NATIONAL FIRE PROTECTION ASSOCIATION (NFPA) 101, LIFE SAFETY CODE, AND THE INTERNATIONAL BUILDING CODE (IBC).  
 4. ALL CONSTRUCTION SHALL BE IN ACCORDANCE WITH THE LATEST EDITIONS OF THE NATIONAL FIRE PROTECTION ASSOCIATION (NFPA) 101, LIFE SAFETY CODE, AND THE INTERNATIONAL BUILDING CODE (IBC).  
 5. ALL CONSTRUCTION SHALL BE IN ACCORDANCE WITH THE LATEST EDITIONS OF THE NATIONAL FIRE PROTECTION ASSOCIATION (NFPA) 101, LIFE SAFETY CODE, AND THE INTERNATIONAL BUILDING CODE (IBC).  
 6. ALL CONSTRUCTION SHALL BE IN ACCORDANCE WITH THE LATEST EDITIONS OF THE NATIONAL FIRE PROTECTION ASSOCIATION (NFPA) 101, LIFE SAFETY CODE, AND THE INTERNATIONAL BUILDING CODE (IBC).  
 7. ALL CONSTRUCTION SHALL BE IN ACCORDANCE WITH THE LATEST EDITIONS OF THE NATIONAL FIRE PROTECTION ASSOCIATION (NFPA) 101, LIFE SAFETY CODE, AND THE INTERNATIONAL BUILDING CODE (IBC).  
 8. ALL CONSTRUCTION SHALL BE IN ACCORDANCE WITH THE LATEST EDITIONS OF THE NATIONAL FIRE PROTECTION ASSOCIATION (NFPA) 101, LIFE SAFETY CODE, AND THE INTERNATIONAL BUILDING CODE (IBC).  
 9. ALL CONSTRUCTION SHALL BE IN ACCORDANCE WITH THE LATEST EDITIONS OF THE NATIONAL FIRE PROTECTION ASSOCIATION (NFPA) 101, LIFE SAFETY CODE, AND THE INTERNATIONAL BUILDING CODE (IBC).  
 10. ALL CONSTRUCTION SHALL BE IN ACCORDANCE WITH THE LATEST EDITIONS OF THE NATIONAL FIRE PROTECTION ASSOCIATION (NFPA) 101, LIFE SAFETY CODE, AND THE INTERNATIONAL BUILDING CODE (IBC).

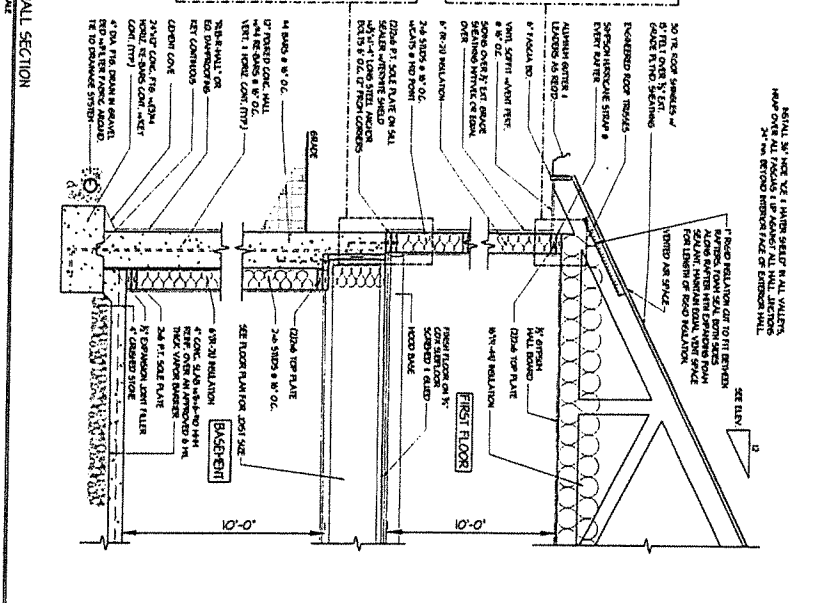

**3 TYPICAL SECTION**  
 NOT TO SCALE







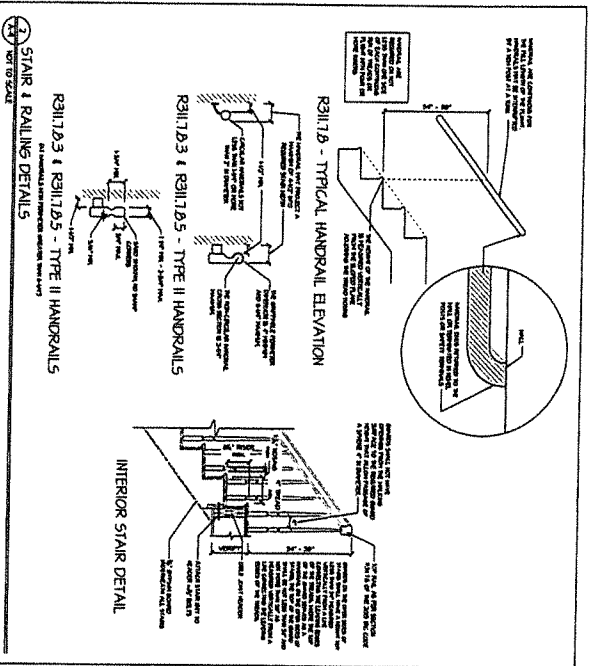


**2 STAIR & RAILING DETAILS**  
 NOT TO SCALE

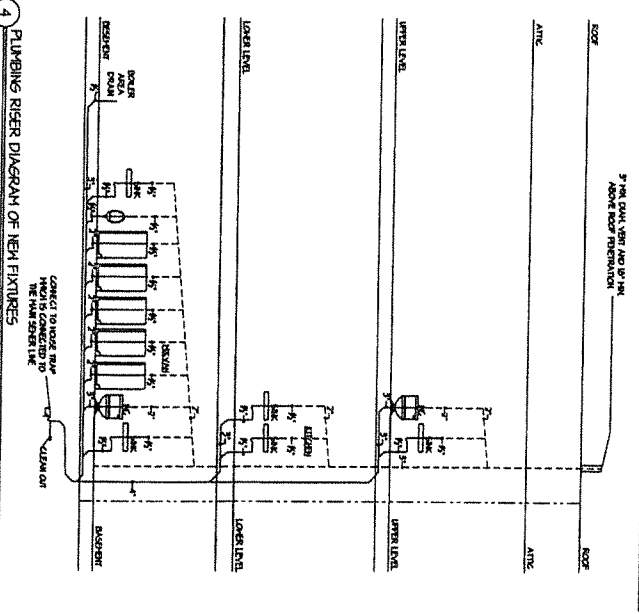

**4 PLUMBING RISER DIAGRAM OF NEW FIXTURES**  
 NOT TO SCALE

**JOIST DETAILS**

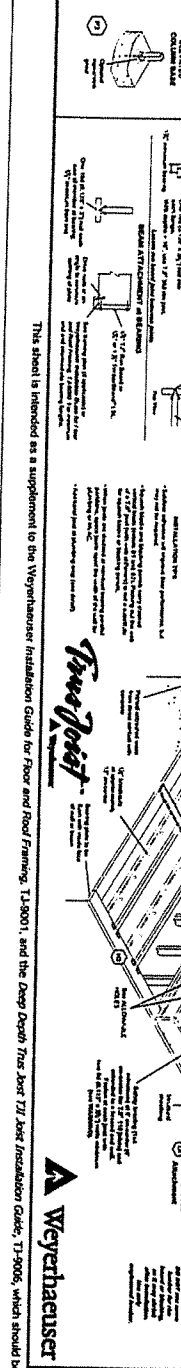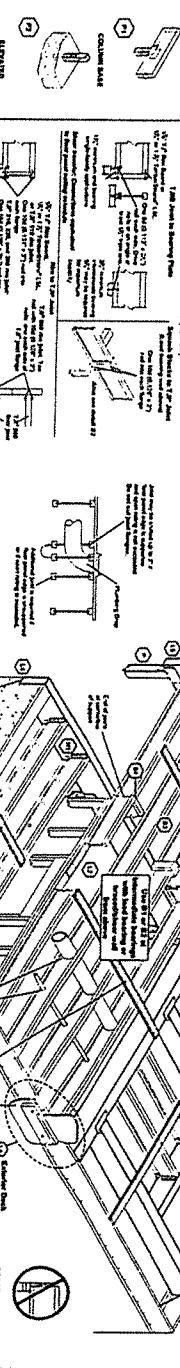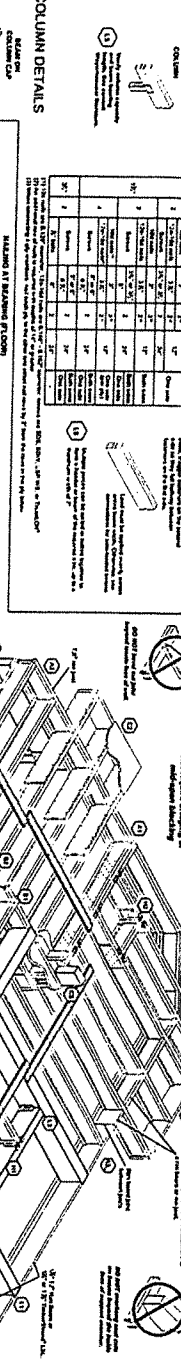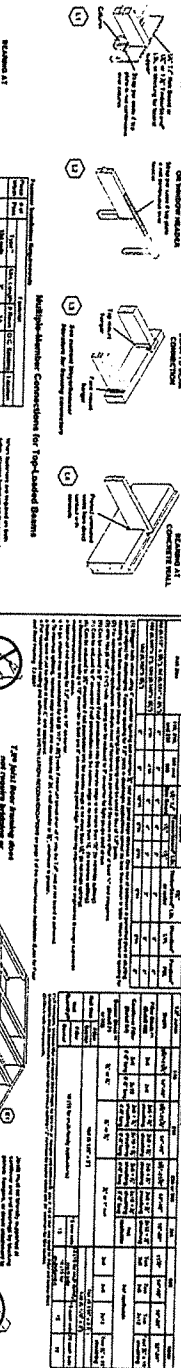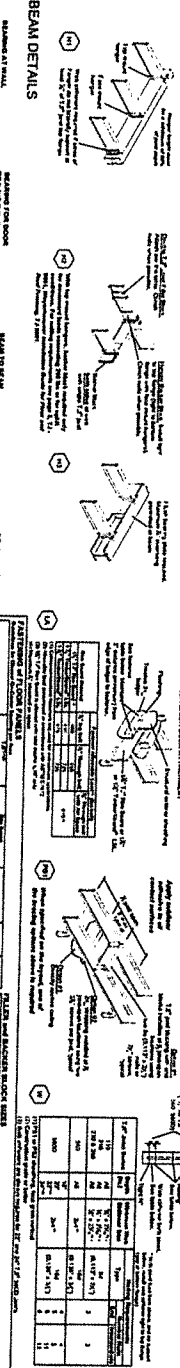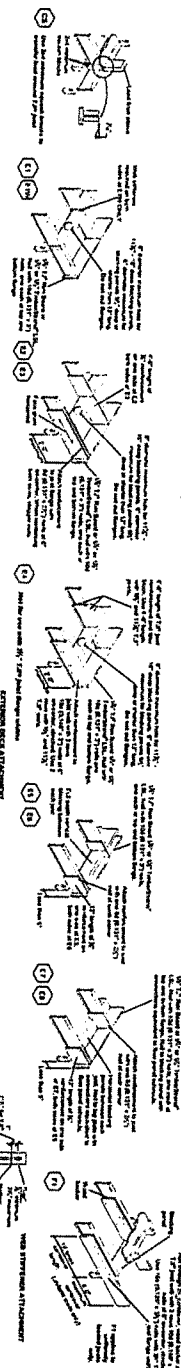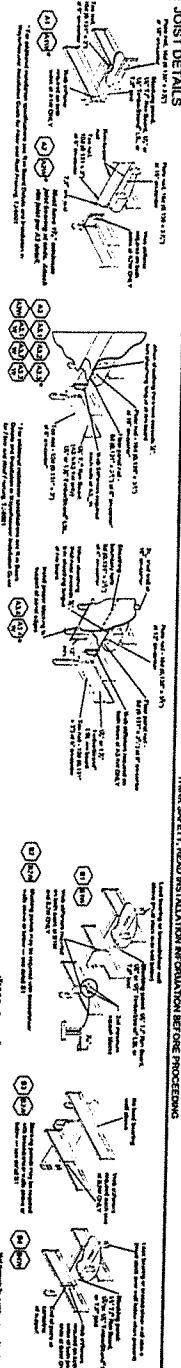

THINK SAFETY. READ INSTALLATION INFORMATION BEFORE PROCEEDING.

**TABLE 1 - ALLOWABLE JOIST SPACING**


Joist Size	Span (ft)	Spacing (ft)
2x8	10	16
2x8	12	16
2x8	14	16
2x8	300	16

**TABLE 2 - ALLOWABLE JOIST SPACING**

Joist Size	Span (ft)	Spacing (ft)
2x10	10	16
2x10	12	16
2x10	14	16
2x10	200	16

**TABLE 3 - ALLOWABLE JOIST SPACING**

Joist Size	Span (ft)	Spacing (ft)
2x12	10	16
2x12	12	16
2x12	14	16
2x12	200	16

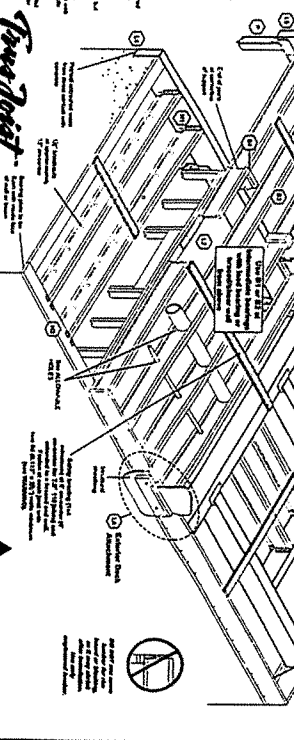

**Weyerhaeuser**  
 This sheet is intended as a supplement to the Weyerhaeuser Installation Guide for Floor and Roof Framing, T1-9001, and the Deep Ocean Tris Joist T1 Joist Installation Guide, T1-9006, which should be referenced for additional information.





## **NORTH ROCKLAND SAFETY PATROL**

**1515 ROUTE 202 SUITE 67  
POMONA NY 10970  
PHONE: 845-442-2900  
EMAIL: OFFICE@NRSPNY.ORG  
WWW.NRSPNY.ORG**



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## **North Rockland Safety Patrol Mission Statement!**

**North Rockland Safety Patrol (NRSP) serves as a vital, culturally sensitive link between law enforcement and local communities.**

**NRSP is committed to security and crime reduction in the Pomona, Haverstraw, and North Rockland areas through partnerships with emergency personnel, social services, and public outreach.**

**As a multi-service organization, NRSP responds to crime and non-crime-related situations. In addition to day and night patrols, trained NRSP volunteers and staff are available to respond to a designated emergency hotline 24/7, provide youth and adult safety programs, ensuring roadways are accessible to emergency vehicles during storms and assist police in special circumstances.**

**EMERGENCY HOTLINE  
845-442-2900**